PROJECT DESCRIPTION

EMBASSY SUITES BLOOMINGTON IS AN EXISTING 195,000 ± SF, EIGHT STORY HOTEL WITH 218 GUESTROOMS, ATRIUM, BALLROOM, MEETING ROOMS, RESTAURANT, POOL AREA AND RELATED BACK-OF-HOUSE SERVICES. THE HOTEL WAS ORIGINALLY CONSTRUCTED IN 1979 AND IS A CONCRETE FRAME STRUCTURE WITH POST-TENSION FLOOR SLABS. THE FIRST FLOOR ELEVATION VARIES THROUGHOUT. EACH GUESTROOM CONSISTS OF A FRONT PARLOR AND BACK BEDROOM SEPARATED BY A TOILET ROOM.

THE SCOPE OF THE PROPOSED RENOVATION RANGES FROM FINISH UPGRADES IN VARIOUS AREAS TO COMPLETE SPACE REMODELING. THE WORK IS DEFINED WITHIN TWO SEPARATE DESIGN PACKAGES.

THE PUBLIC AREA PACKAGE INCLUDES REFUBISHMENT OF THE BUILDING EXTERIOR AND PORTE COCHERE ALONG WITH SITE LIGHTHING UPGRADES. THE INTERIOR GROUND FLOOR LEVEL WORK INCLUDES RECONFIGURATION OF THE PUBLIC RESTROOMS, BAR, PREFUNCTION AND OFFICE SPACES. EXISTING PLANTERS AND FOUNTAIN ARE TO BE REMOVED FROM THE ATRIUM SPACE ALONG WITH A COMPLETE RENOVATION OF THE BREAKFAST BAR AND SEATING. ACCESSIBLE ROUTES TO THE EXISTING LEVEL CHANGES ARE TO BE ADDED AND UPGRADED. THE PUBLIC AREA SCOPE INCLUDES ALL RELATED MECHANICAL, PLUMBING, LIGHTING AND ELECTRICAL WORK.

THE GUESTROOM PACKAGE INCLUDES THE MODERIZAITION OF FINISHES THROUGHOUT, ADA ACCESSESSIBILITY IMPROVEMENTS AND THE CONVERSION OF (15) TWO-BAY EXECUTIVE SUITES INTO (30) SINGLE BAY GUESTROOMS. THIS INCLUDES THE ADDITION OF EXTERIOR WINDOWS AT THE NEW GUESTROOMS. THE GUESTROOM SCOPE INCLUDES ALL RELATED MECHANICAL, PLUMBING, LIGHTING AND ELECTRICAL WORK.

CONSTRUCTION WORK WILL BE STAGED AND TEMPORARY ACCOMMODATIONS PROVIDED TO ALLOW FOR CONTINUED OPERATION OF THE HOTEL DURING CONSTRUCTION.

PROJECT DATA

PROJECT: EMBASSY SUITES - BLOOMINGTON RENOVATION 2800 AMERICAN BLVD. WEST,

BLOOMINGTON, MN 55431

OWNER: BLOOMINGTON HOTEL OWNER, SPE, LLC

LEGAL DESCRIPTION: PARCEL A:

LOT 1, BLOCK 1; AND OUTLOT A, HOMETELS OF AMERICA ADDITION, HENNEPIN COUNTY, MINNESOTA.

PARCEL B:

LOT 1, BLOCK 1, TARGET BLOOMINGTON FIRST ADDITION, HENNEPIN COUNTY, MINNESOTA

71.4'

EXISTING USE ZONE: CS-1 (HOTEL - NO CHANGE PROPOSED)

EXISTING ROOM COUNT: 218 ROOMS

EXISTING <u>REQUIRED</u> Maximum Lot Area (SQ. FT.) 120,000 271,776 (6.239 +/- AC) N/S Minimum Frontage 805.2' Minimum Lot Width 200' 485' +/-Max. Building Coverege 30% 16% Max. Building Height NONE Minimum Setbacks Front 129.3'

ear 30' 80.4'

22.5'

222

EXISTING PARKING: 369 TOTAL SPACES

BUILDING AREAS:

1ST FLOOR:
2ND FLOOR:
3RD - 8TH TYP:
BUILDING TOTAL
42,915 SQ.FT
18,475 SQ.FT
22,315 SQ.FT PER FLOOR
195,280 SQ.FT

OCCUPANCY CLASSIFICATIONS: R-1, A-2, A-3 AND B

CONSTRUCTION TYPE:

Side

PROPOSED ROOM COUNT:

ACCESSIBLE ROOMS OTHERS PROPOSED TOTAL ROOMS

232
(14 ADDITIONAL ROOM KEYS PROPOSED BY CONVERTING EXISTING DOUBLE-BAY SUITES WITH MEETING ROOMS INTO SINGLE BAY

PARKING REQUIREMENTS:

1.1 SPACES PER ROOM PLUS ADDITIONAL SPACES EQUAL TO 1/3 CAPACITY OF MEETING/ BANQUET AREA PLUS 1 SPACE FOR EACH 2.5 SEATS IN BAR/RESTAURANT

REQUIRED PARKING SPACES:

415 SPACES (REDUCED TO ____ SPACES BASED ON FLEXIBILITY FOR PARKING APPROVED BY CITY COUNCIL ON __/_/_, CASE #_____)

PROPOSED PARKING:

376 STANDARD SPACES

__8 ACCESSIBLE SPACES
384 TOTAL PARKING SPACES
(15 ADDITIONAL PARKING SPACES
PROPOSED BY REMOVAL OF EXTRANEOUS
SITE STRUCTURES AND RESTRIPING)

APPLICABLE CODES

APPLICABLE CODES & STANDARDS, INCLUDING, BUT NOT LIMITED TO THE FOLLOWING:

2007 MINNESOTA STATE BUILDING CODE

2006 INTERNATIONAL BUILDING CODE WITH STATE AMENDMENTS/ CHAPTER 1305
MINNESOTA ACCESSIBILITY CODE/ CHAPTER 1341

2006 INTERNATIONAL FIRE CODE WITH STATE AMENDMENTS/ CHAPTER 7510
2011 NATIONAL ELECTRICAL CODE
MINNESOTA STATE PLUMBING CODE WITH STATE AMENDMENTS/ CHAPTER 7510
MINIMUM PLUMBING FIXTURES/ 2006 IBC CHAPTER 29 AS AMENDED

MINNESOTA MECHANICAL CODE/ CHAPTER 1346/2006IMC 2006IFGC
MINNESOTA COMMERCIAL ENERGY CODE 1323/ ASHRAE STANDARD 90.1-2004

FOR PLANNING DEPARTMENT REVIEW JUNE 17, 2014

Sheet Title

NEW SITE PLAN

E M B A S S Y S U I T E S

EMBASSY SUITES-

2800 American Blvd. West,

REASON

Bloomington, MN 55431

PROJECT NO.

REV DATE

NO. ISSUED


BLOOMINGTON


Sheet No.
AS 102

1 NEW - SITE PLAN

A1/A-201 1" = 40'-0"

0' 20' 40' 80' 160' NORTH

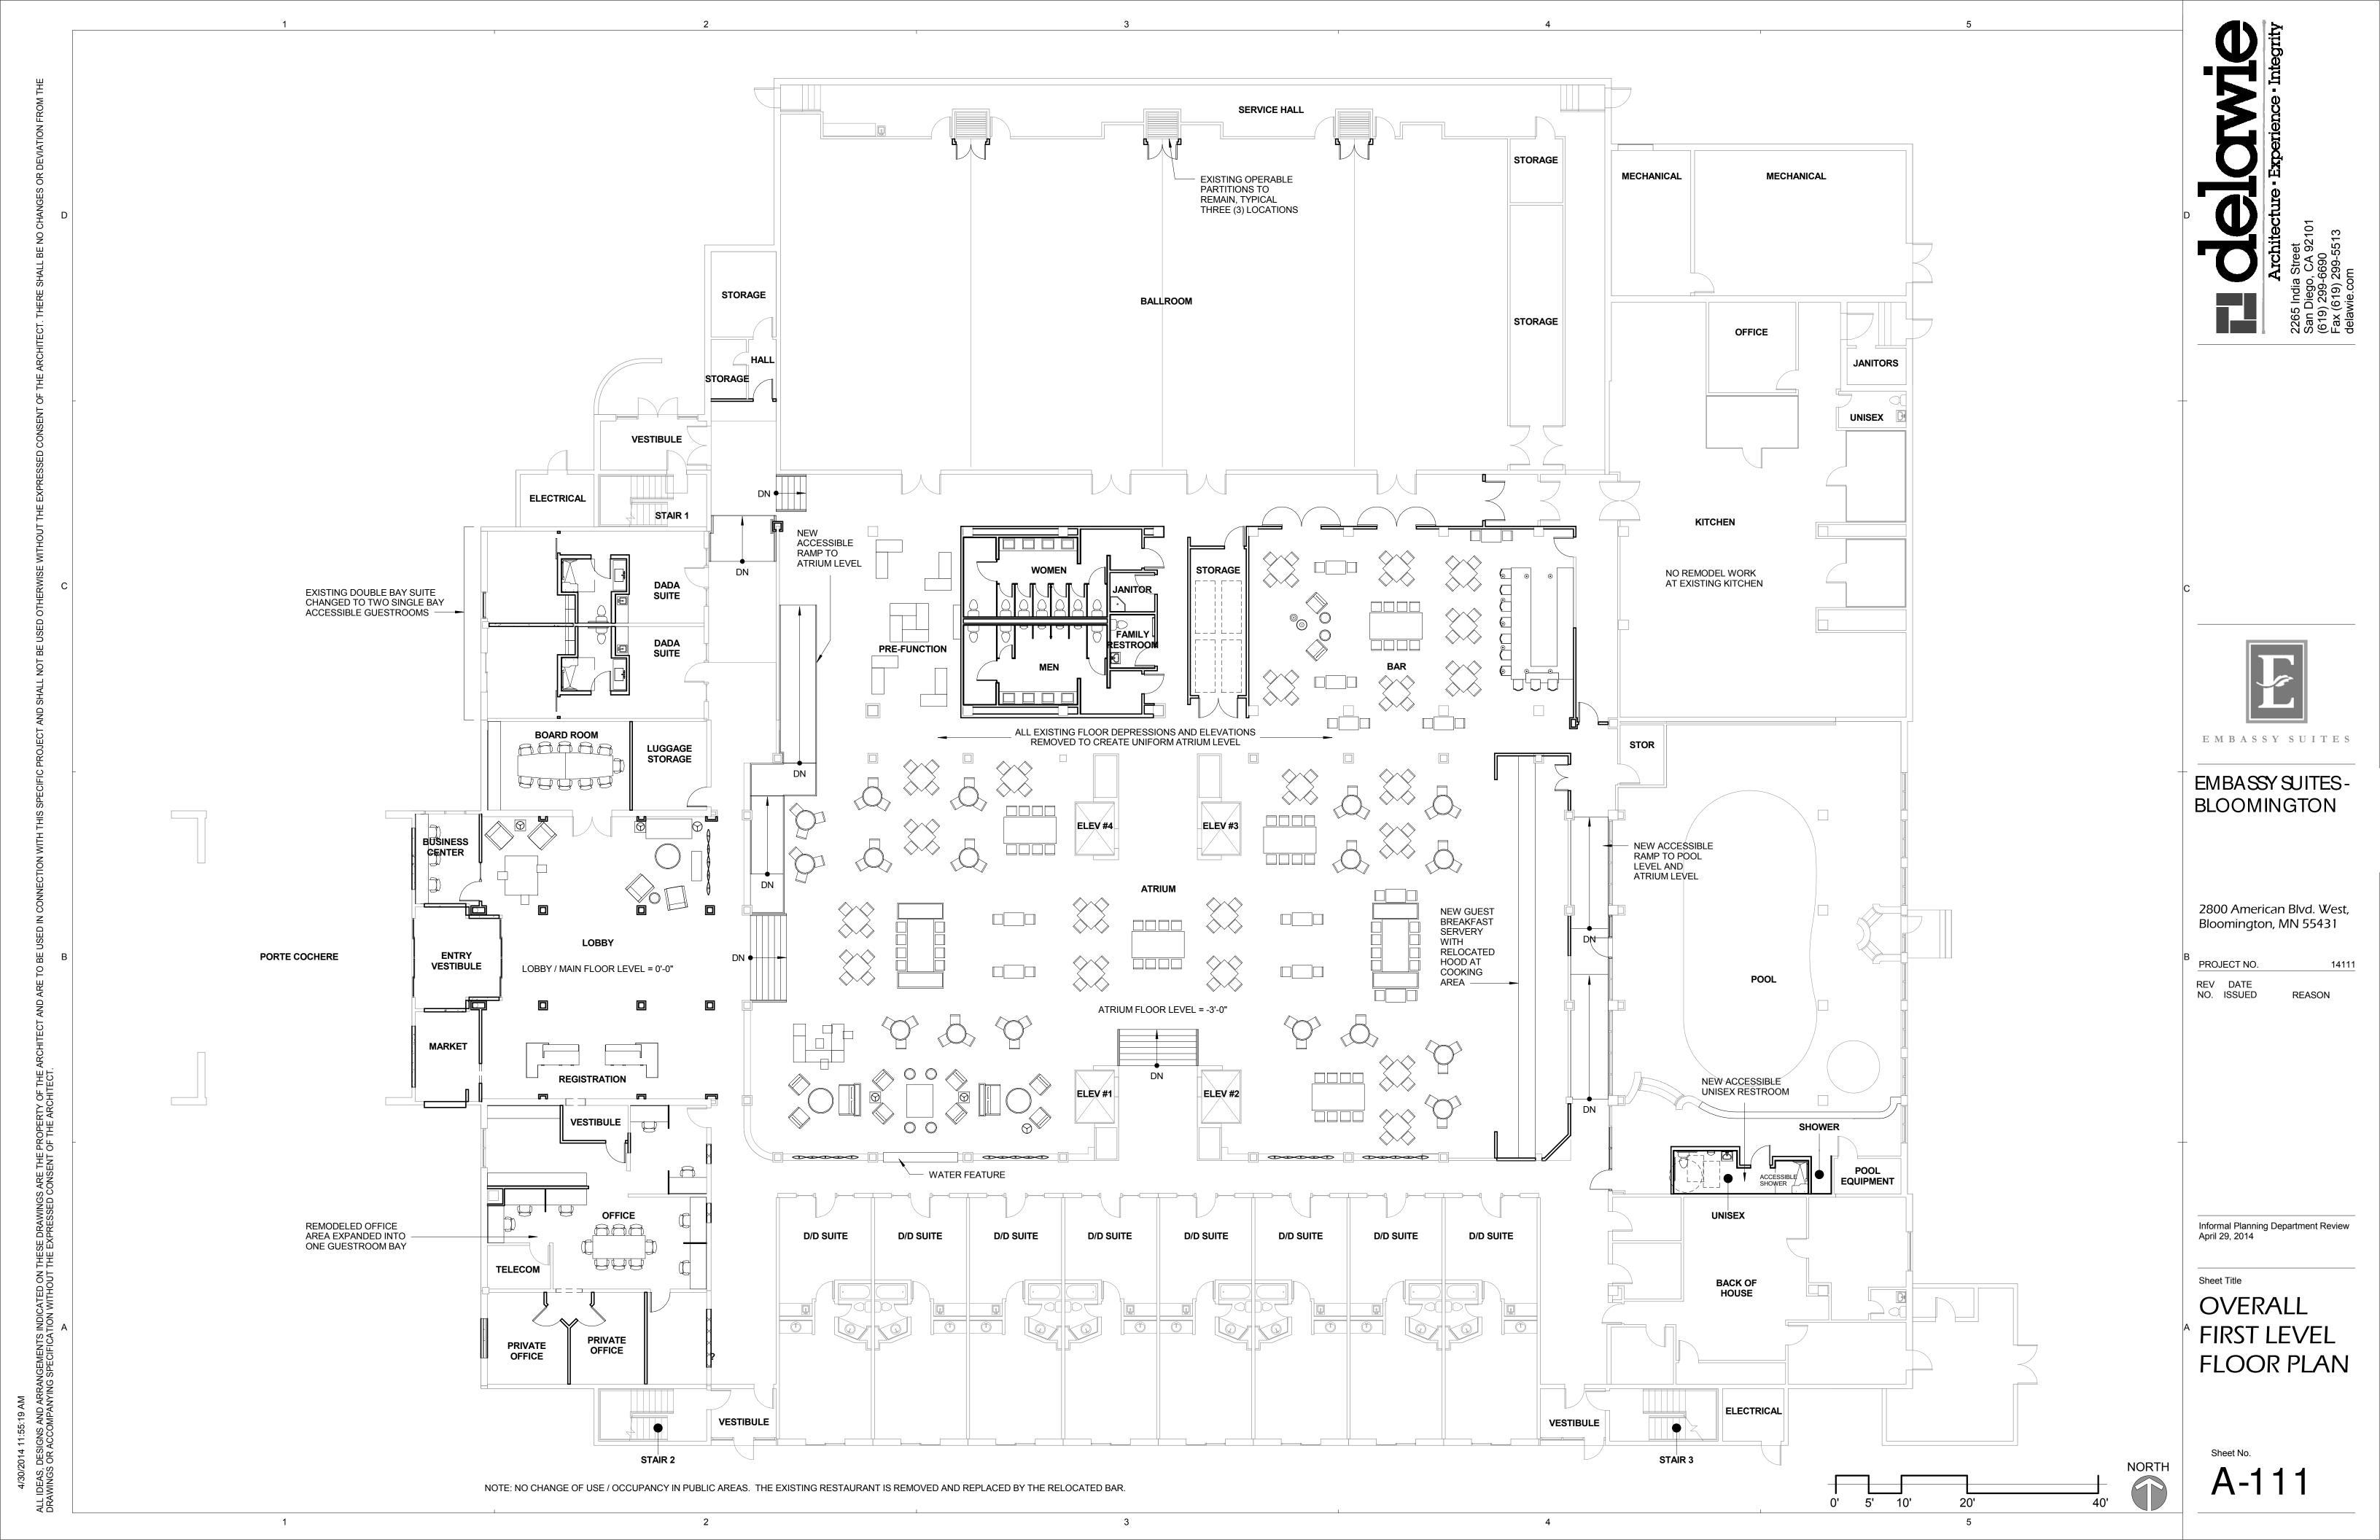

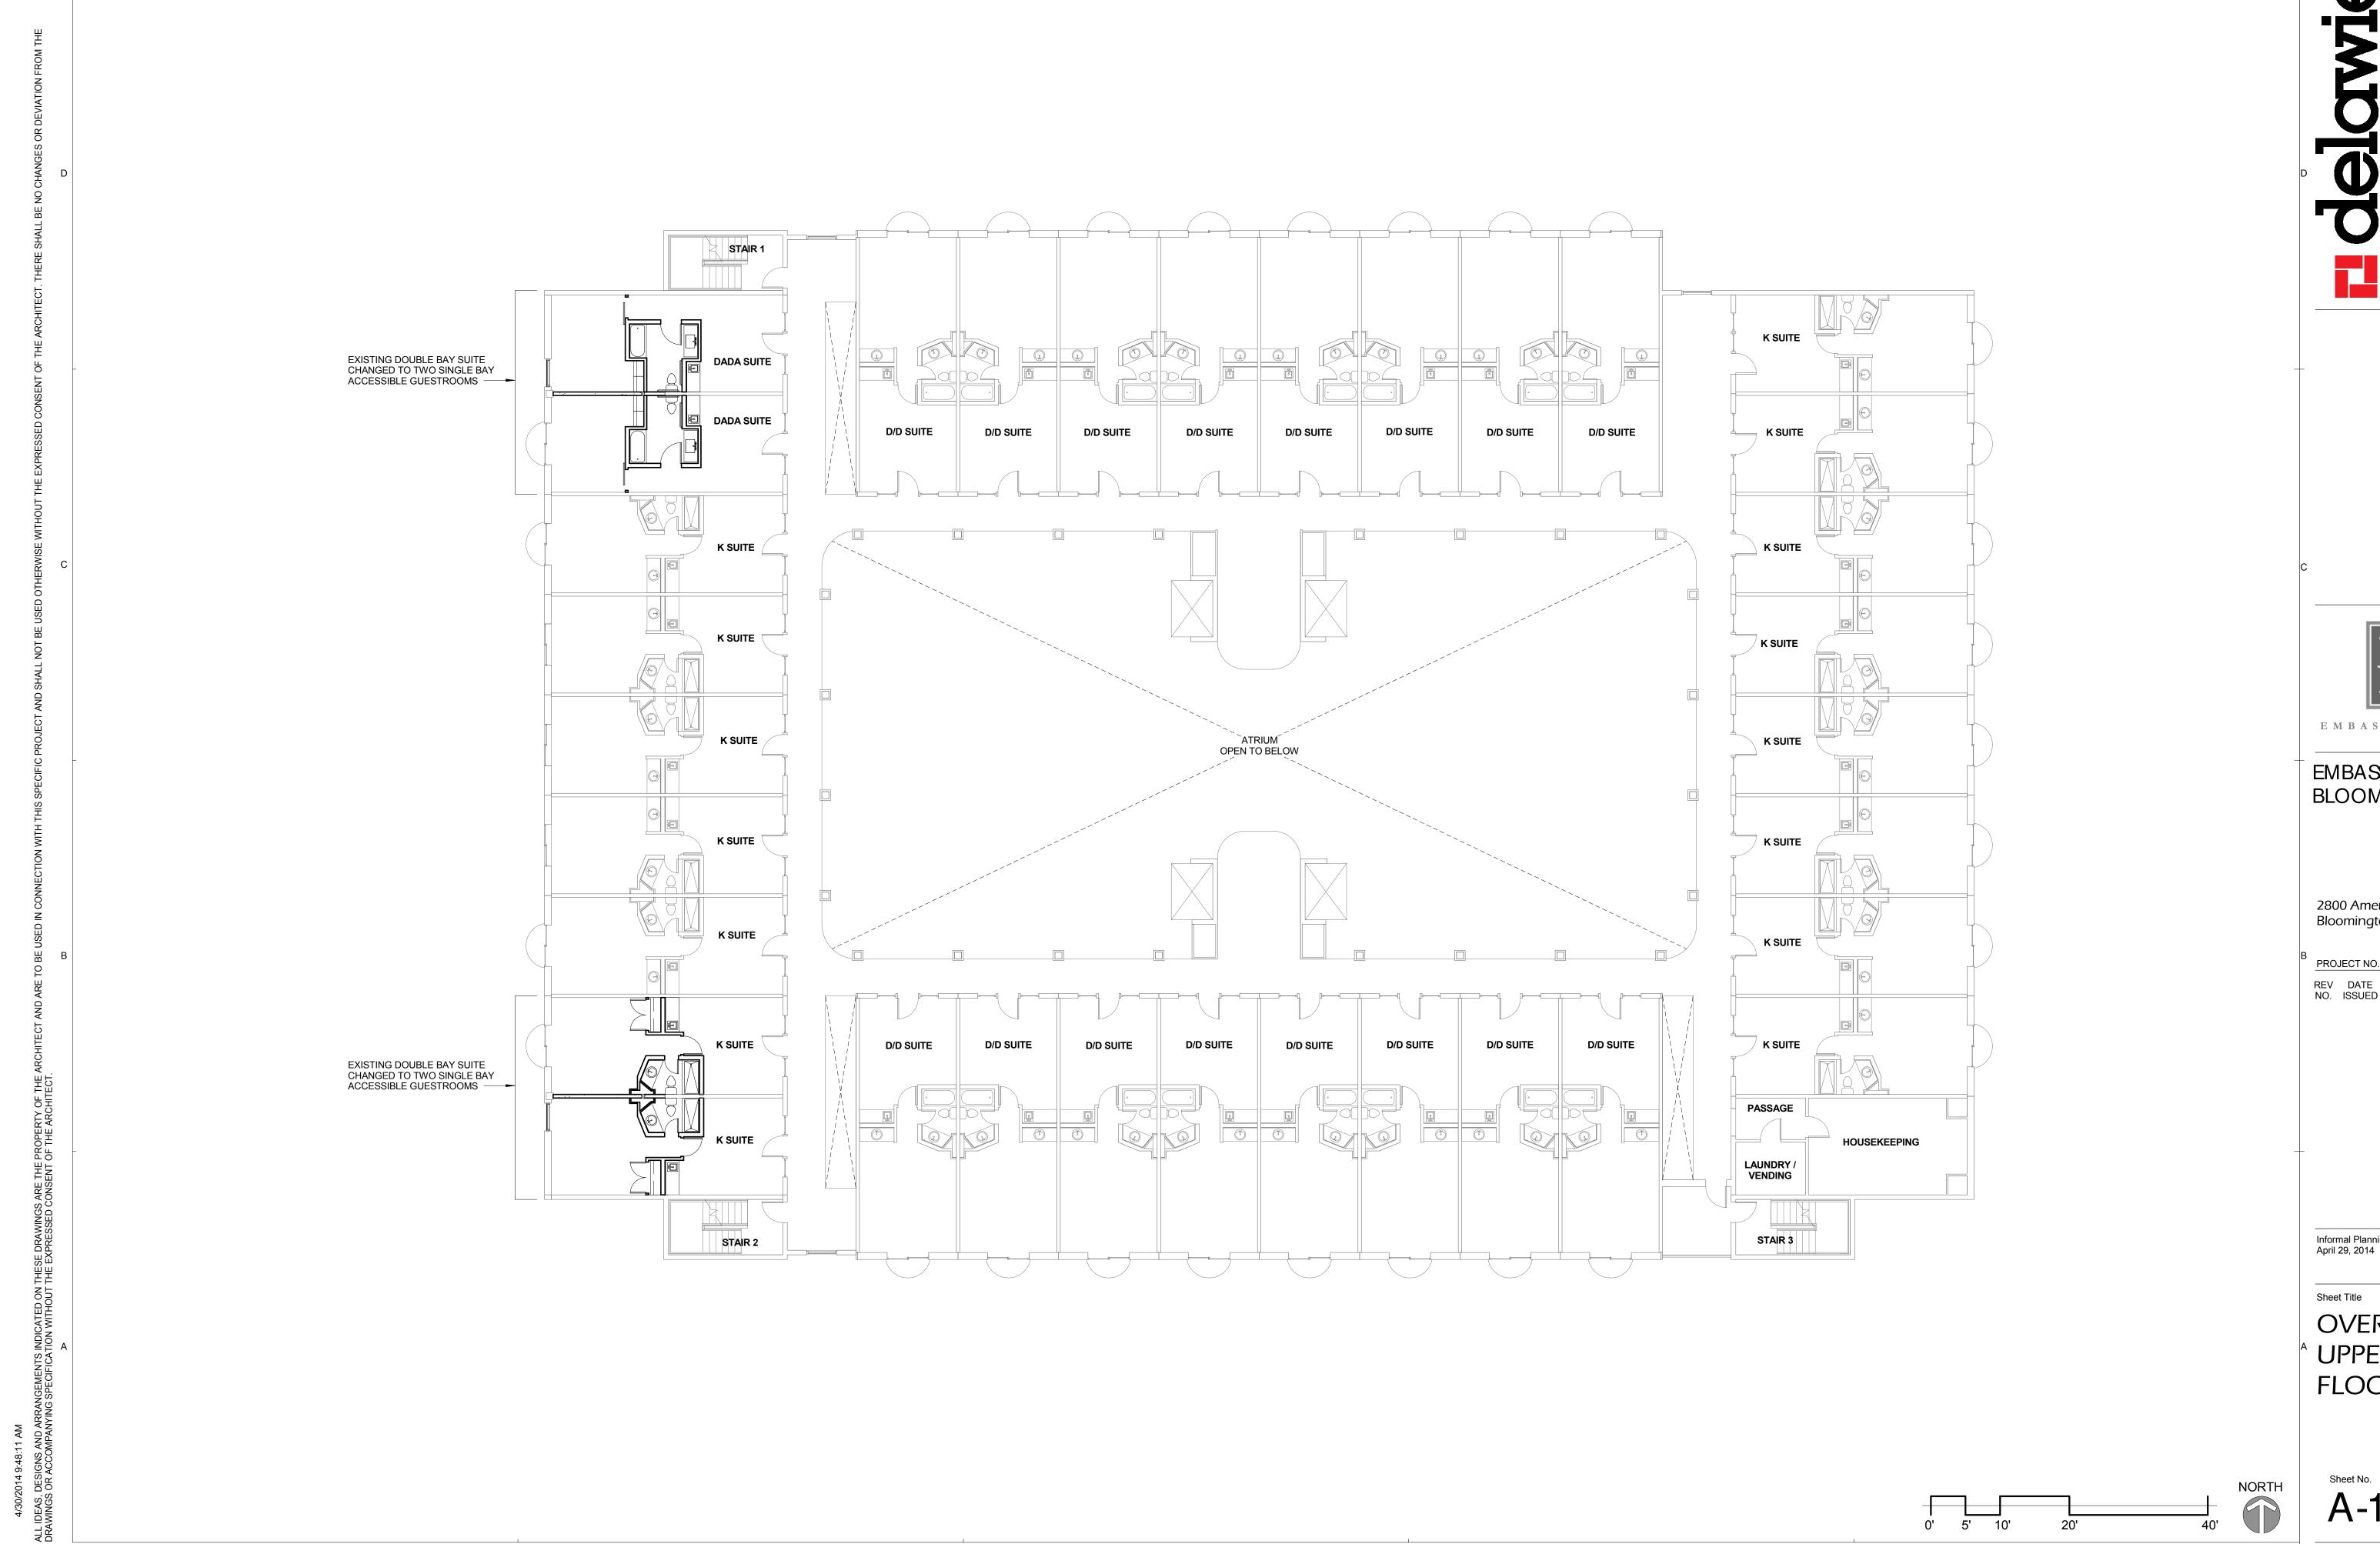

Architecture - Experience - Integrity
San Diego, CA 92101
(619) 299-6690



EMBASSY SUITES-BLOOMINGTON

2800 American Blvd. West, Bloomington, MN 55431


B PROJECT NO. 141


REV DATE
NO. ISSUED REASON

Informal Planning Department Review April 29, 2014

OVERALL UPPER LEVEL FLOOR PLAN

Sheet No. **A-112**

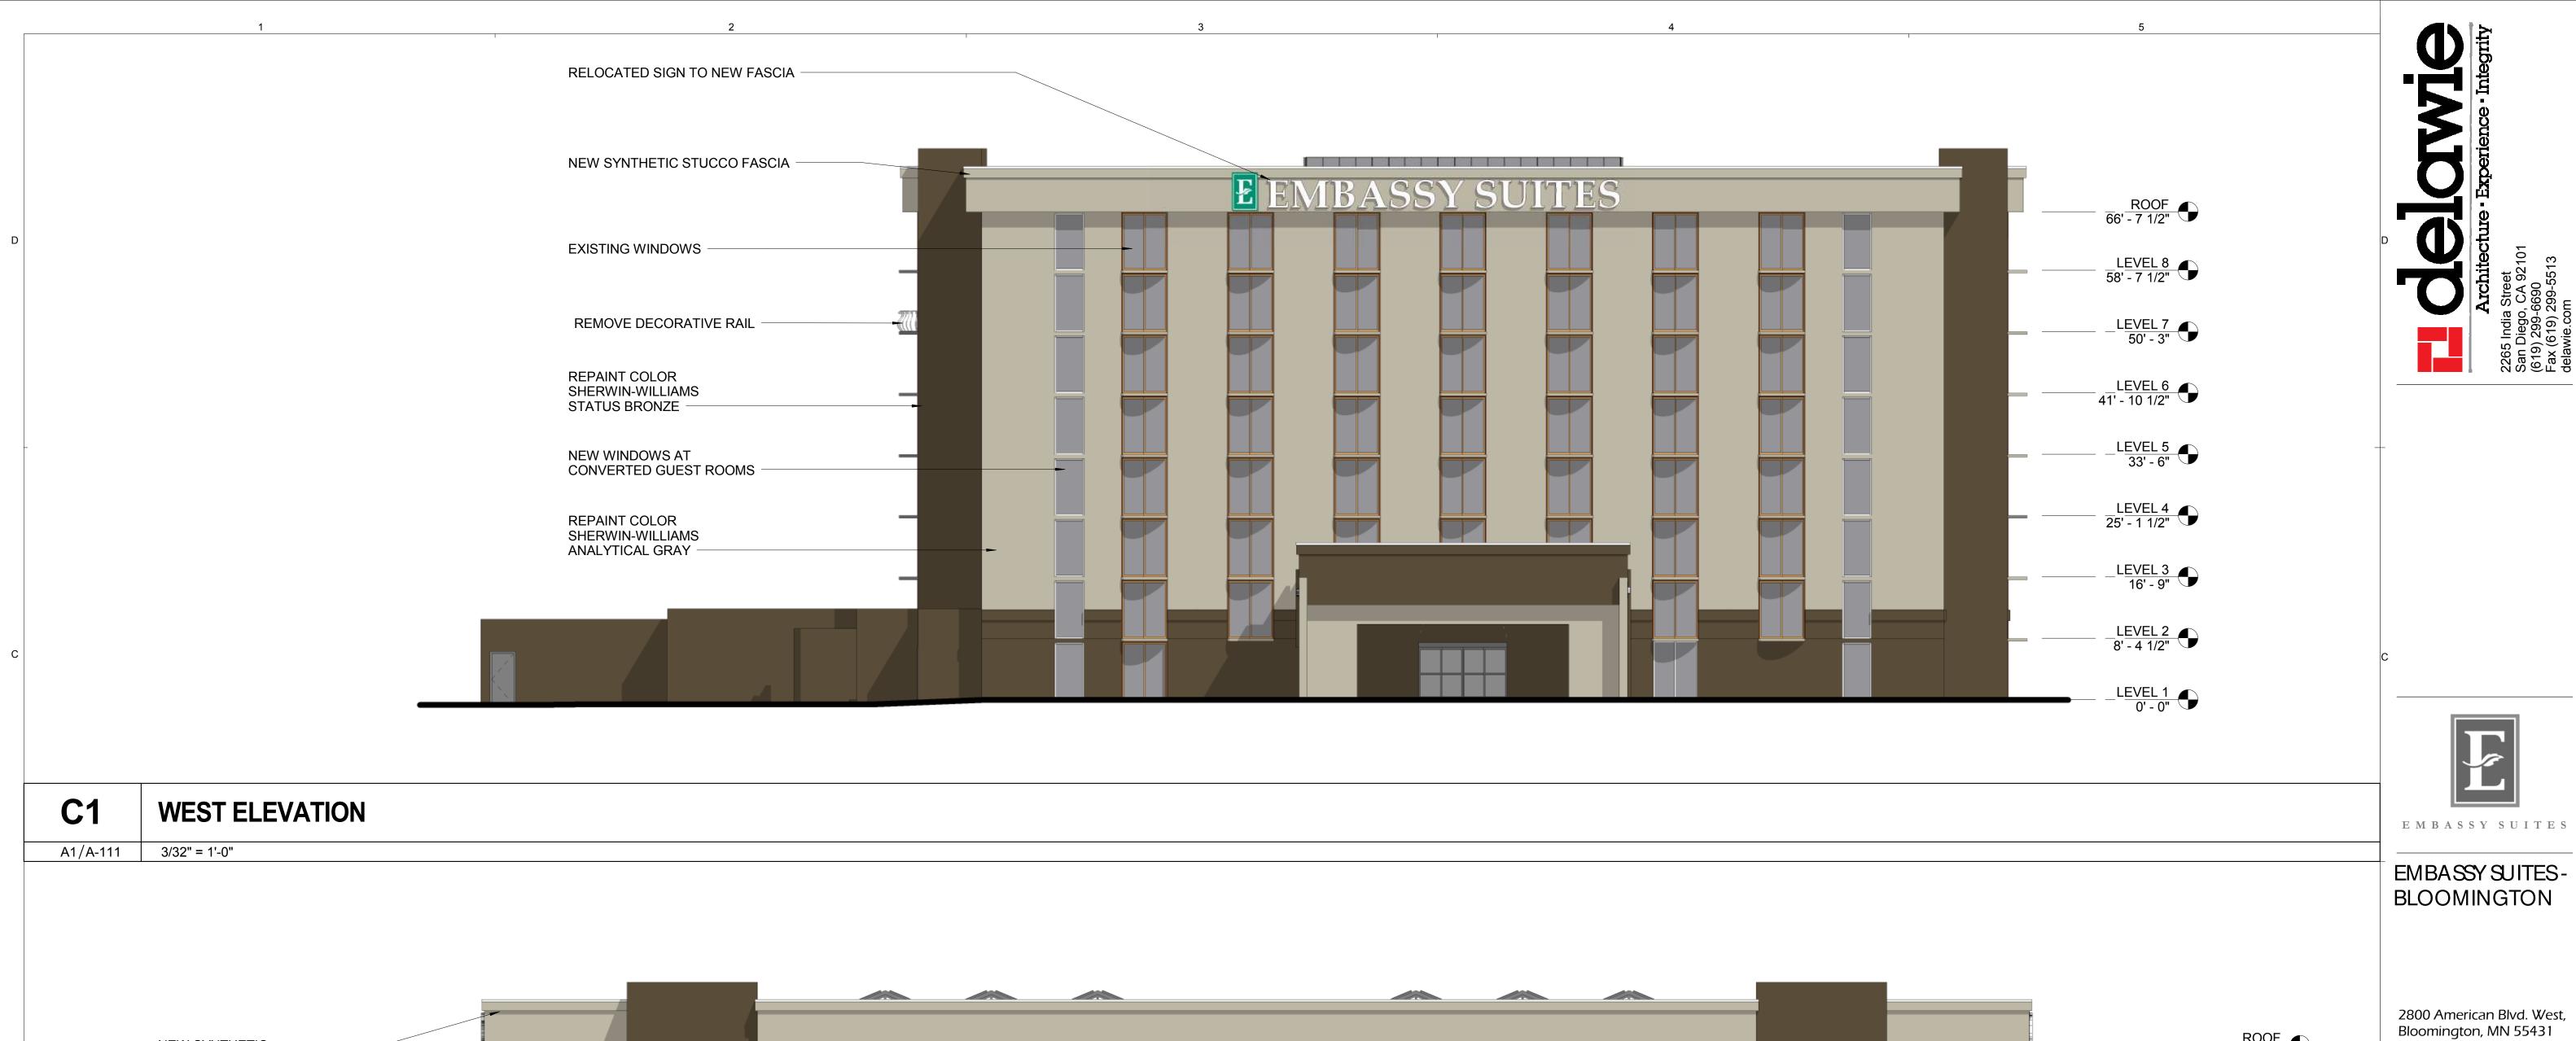

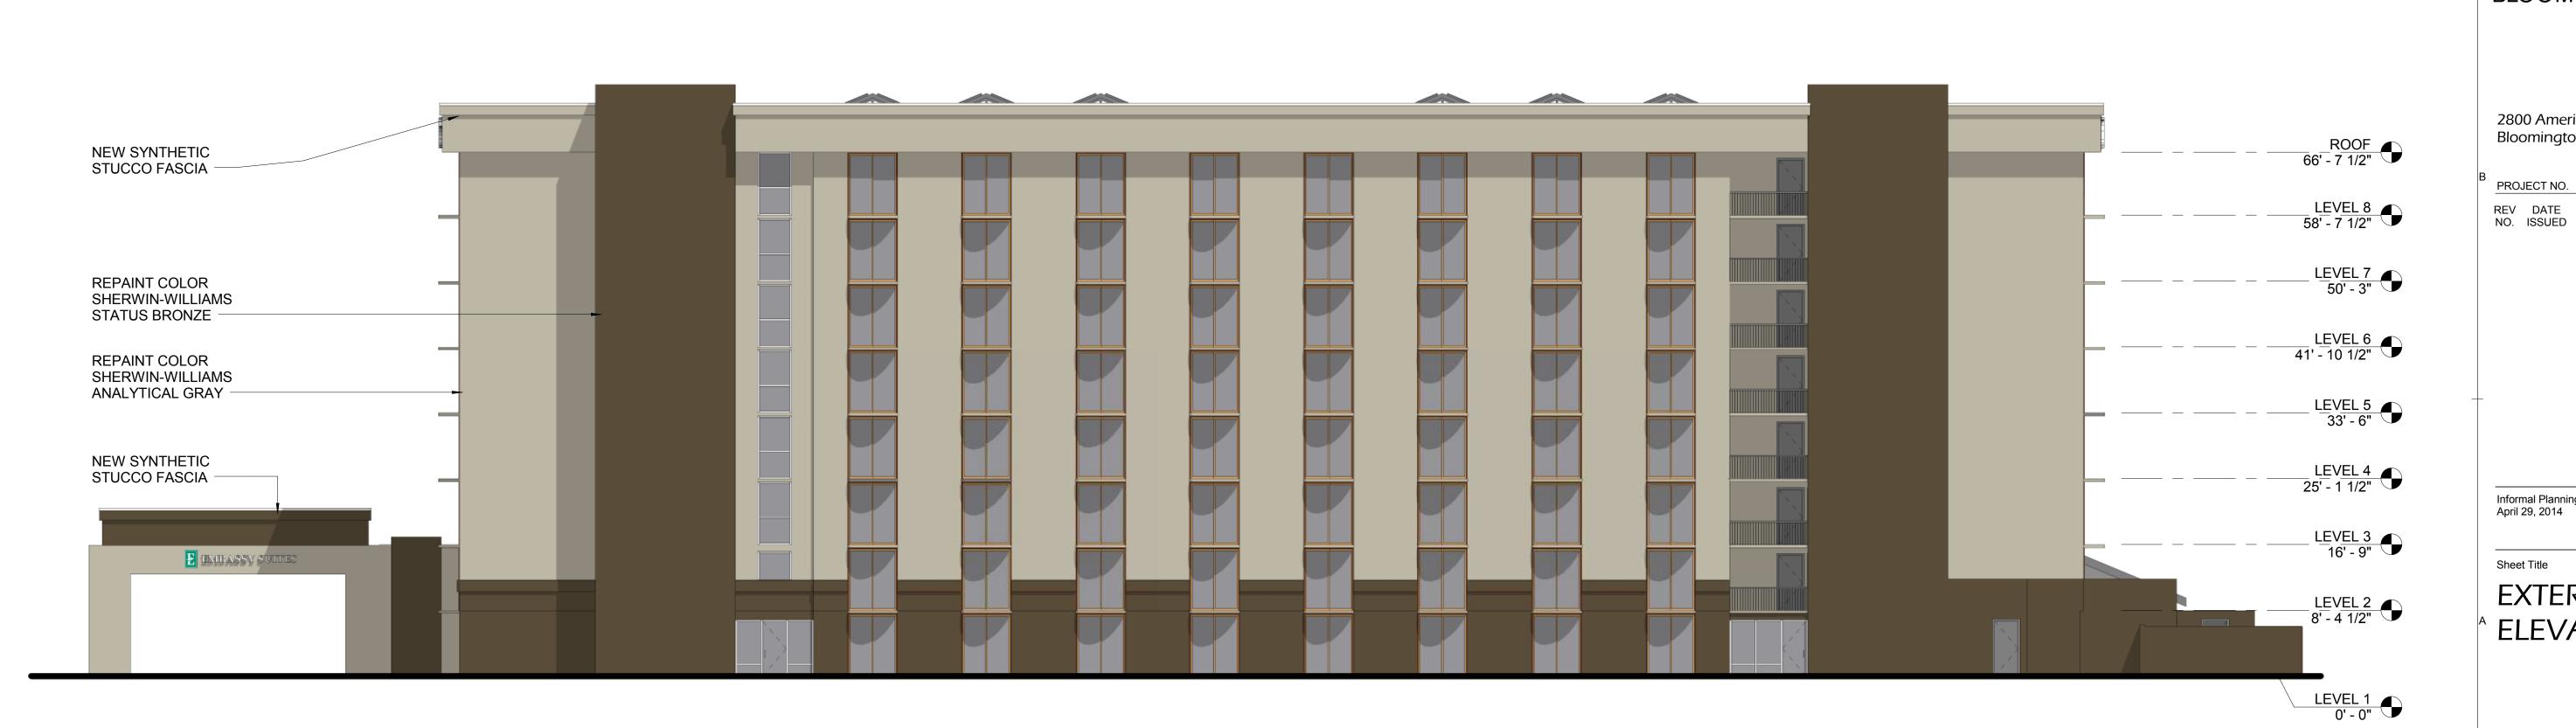

4/29/2014 5:02:26 PM DEAS, DESIGNS AND ARRANGEMENTS INDICATED ON THESE DRAWINGS ARE THE PROPERTY OF THE WINGS OR ACCOMPANYING SPECIFICATION WITHOUT THE EXPRESSED CONSENT OF THE ARCHITECT.

A1

A1/A-111

SOUTH ELEVATION

3/32" = 1'-0"

Informal Planning Department Review April 29, 2014

ELEVATIONS

EXTERIOR


Sheet Title

A-201

PROJECT NO.

14111

REASON

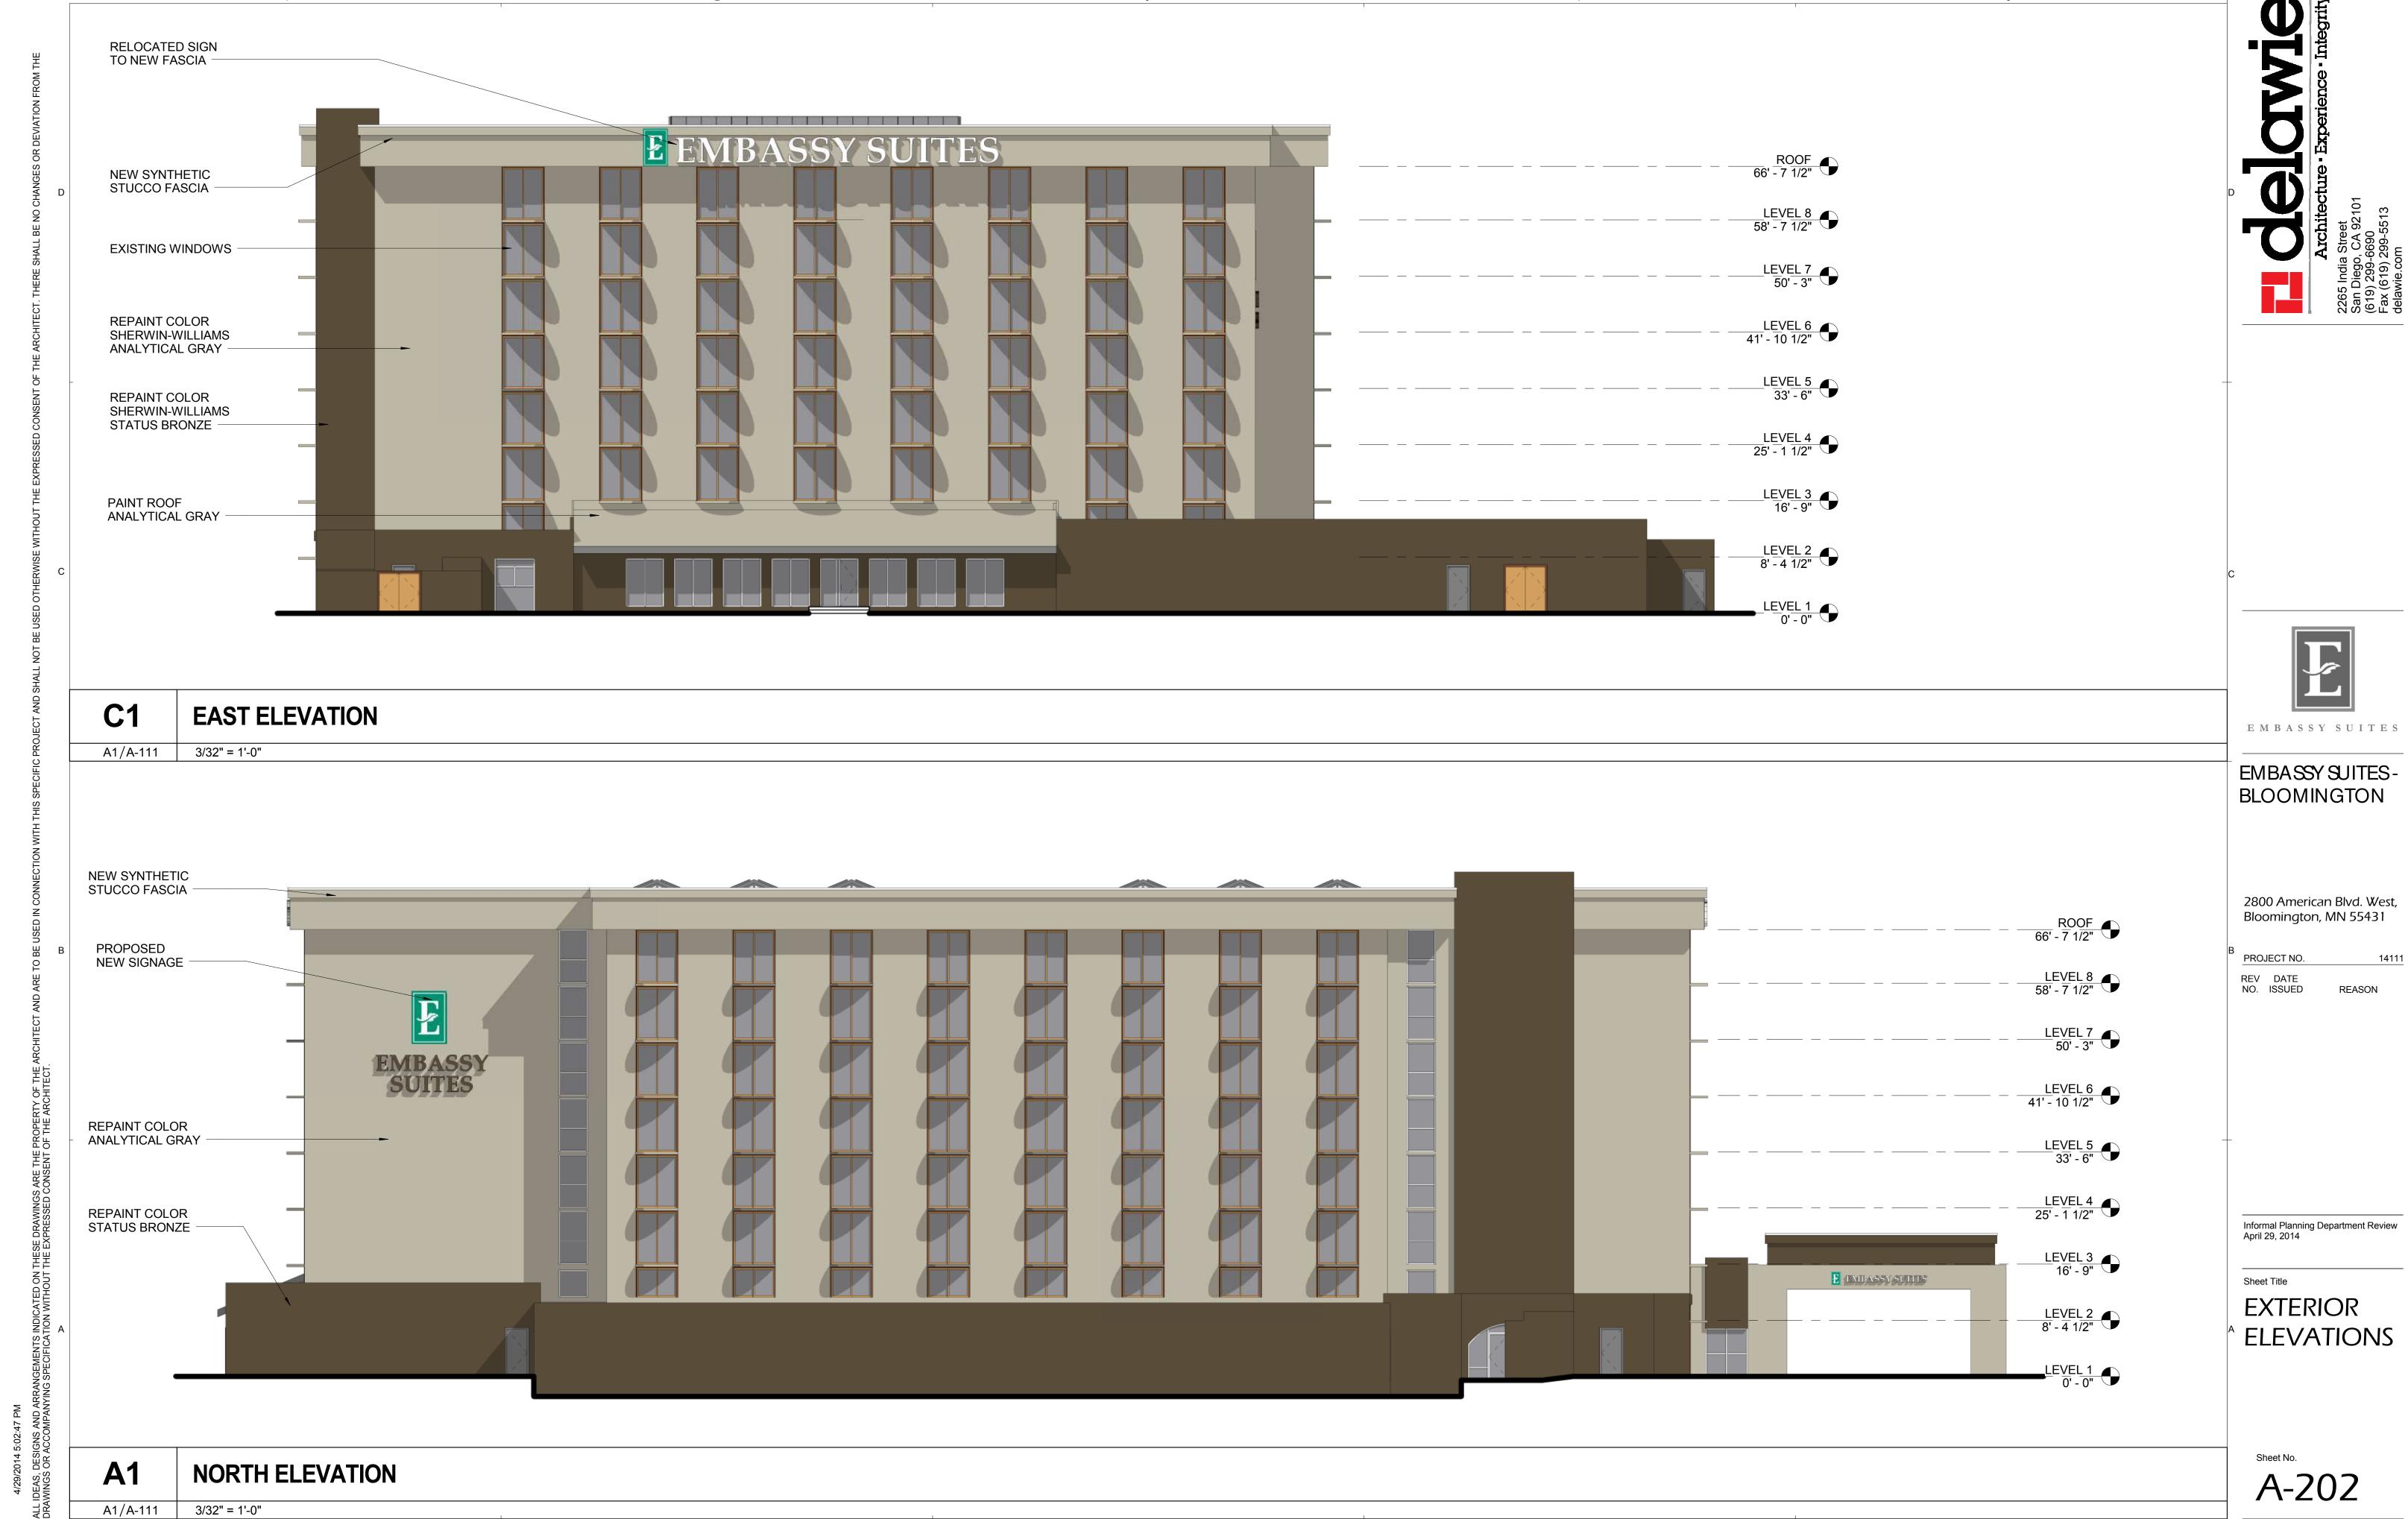





NORTHEAST VIEW



SOUTHWEST VIEW



EMBASSY SUITES-BLOOMINGTON

2800 American Blvd. West, Bloomington, MN 55431

PROJECT NO. REV DATE NO. ISSUED REASON

Informal Planning Department Review April 29, 2014


VIEWSOF PRO PO SED **EXTERIOR**


A-901

Informal Planning Department Review April 29, 2014


A-902



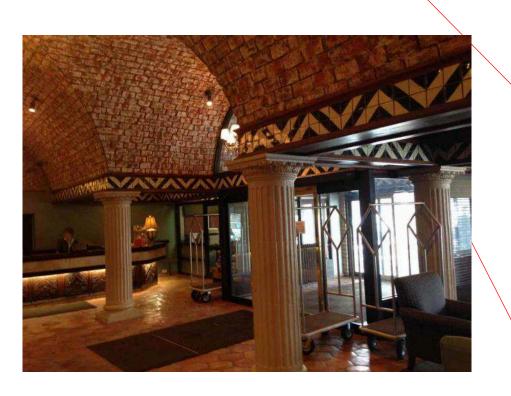

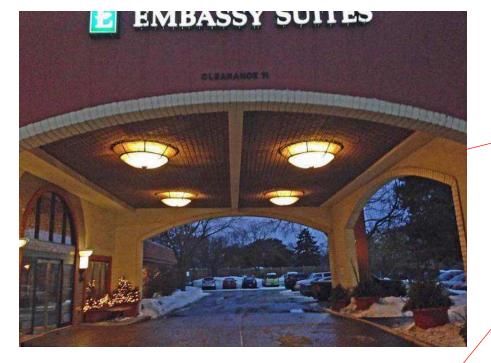




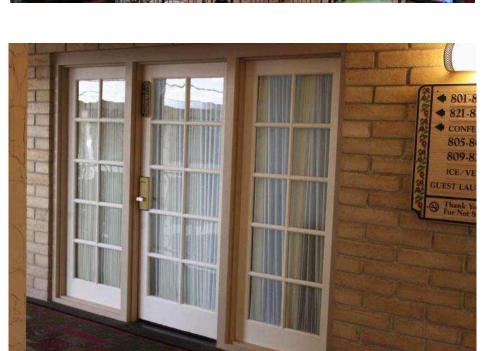





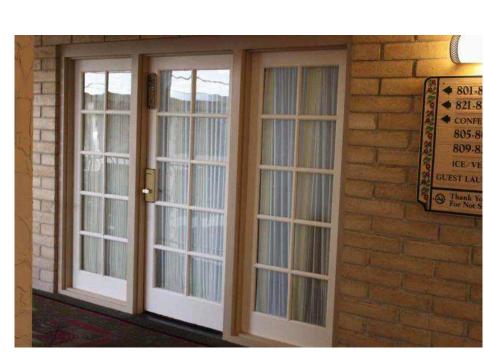












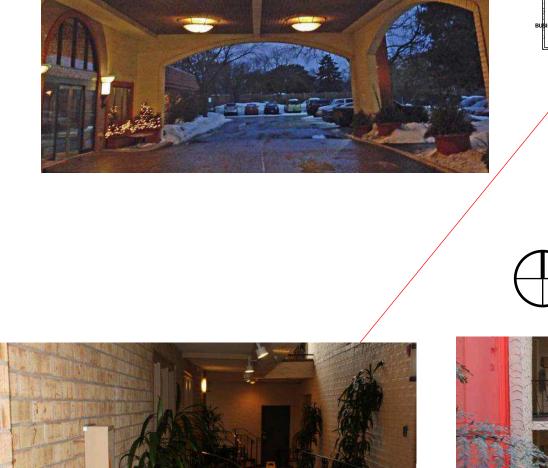





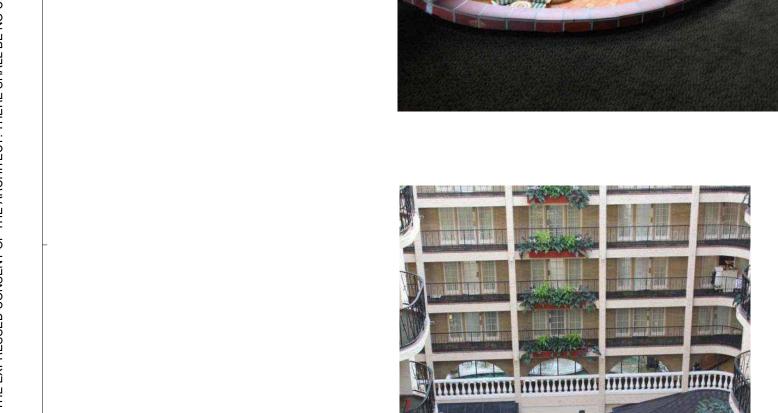

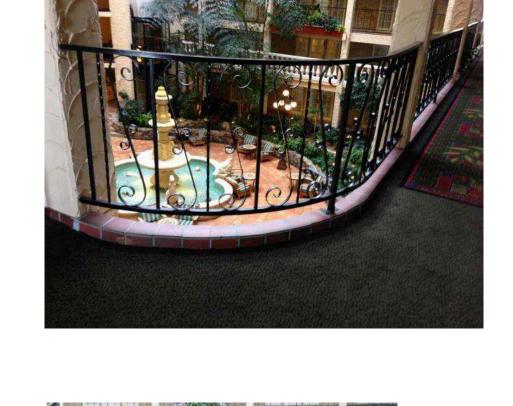




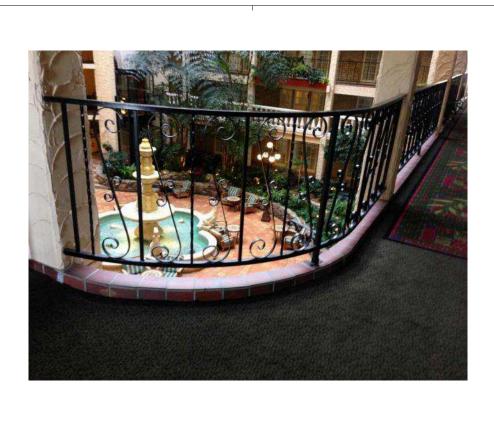

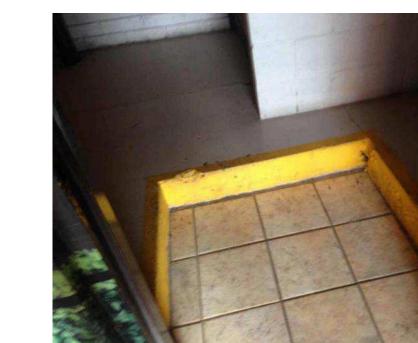







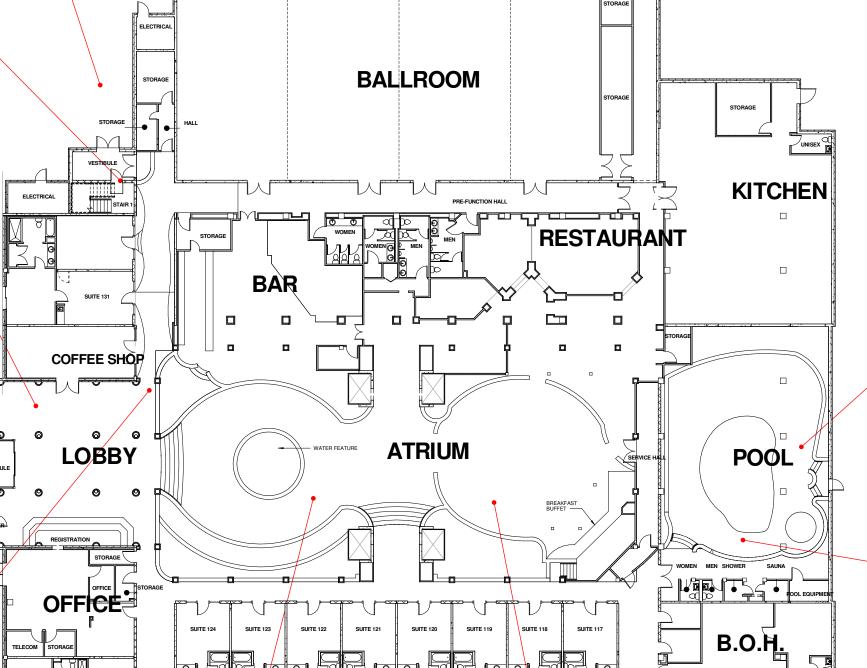





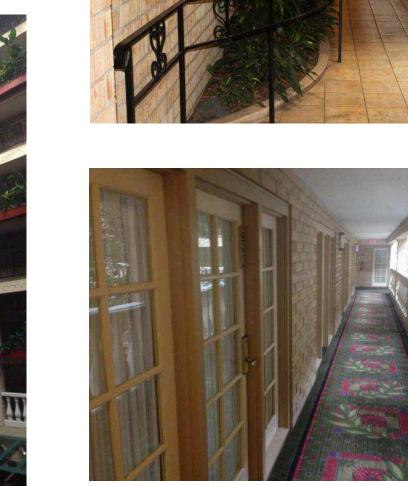

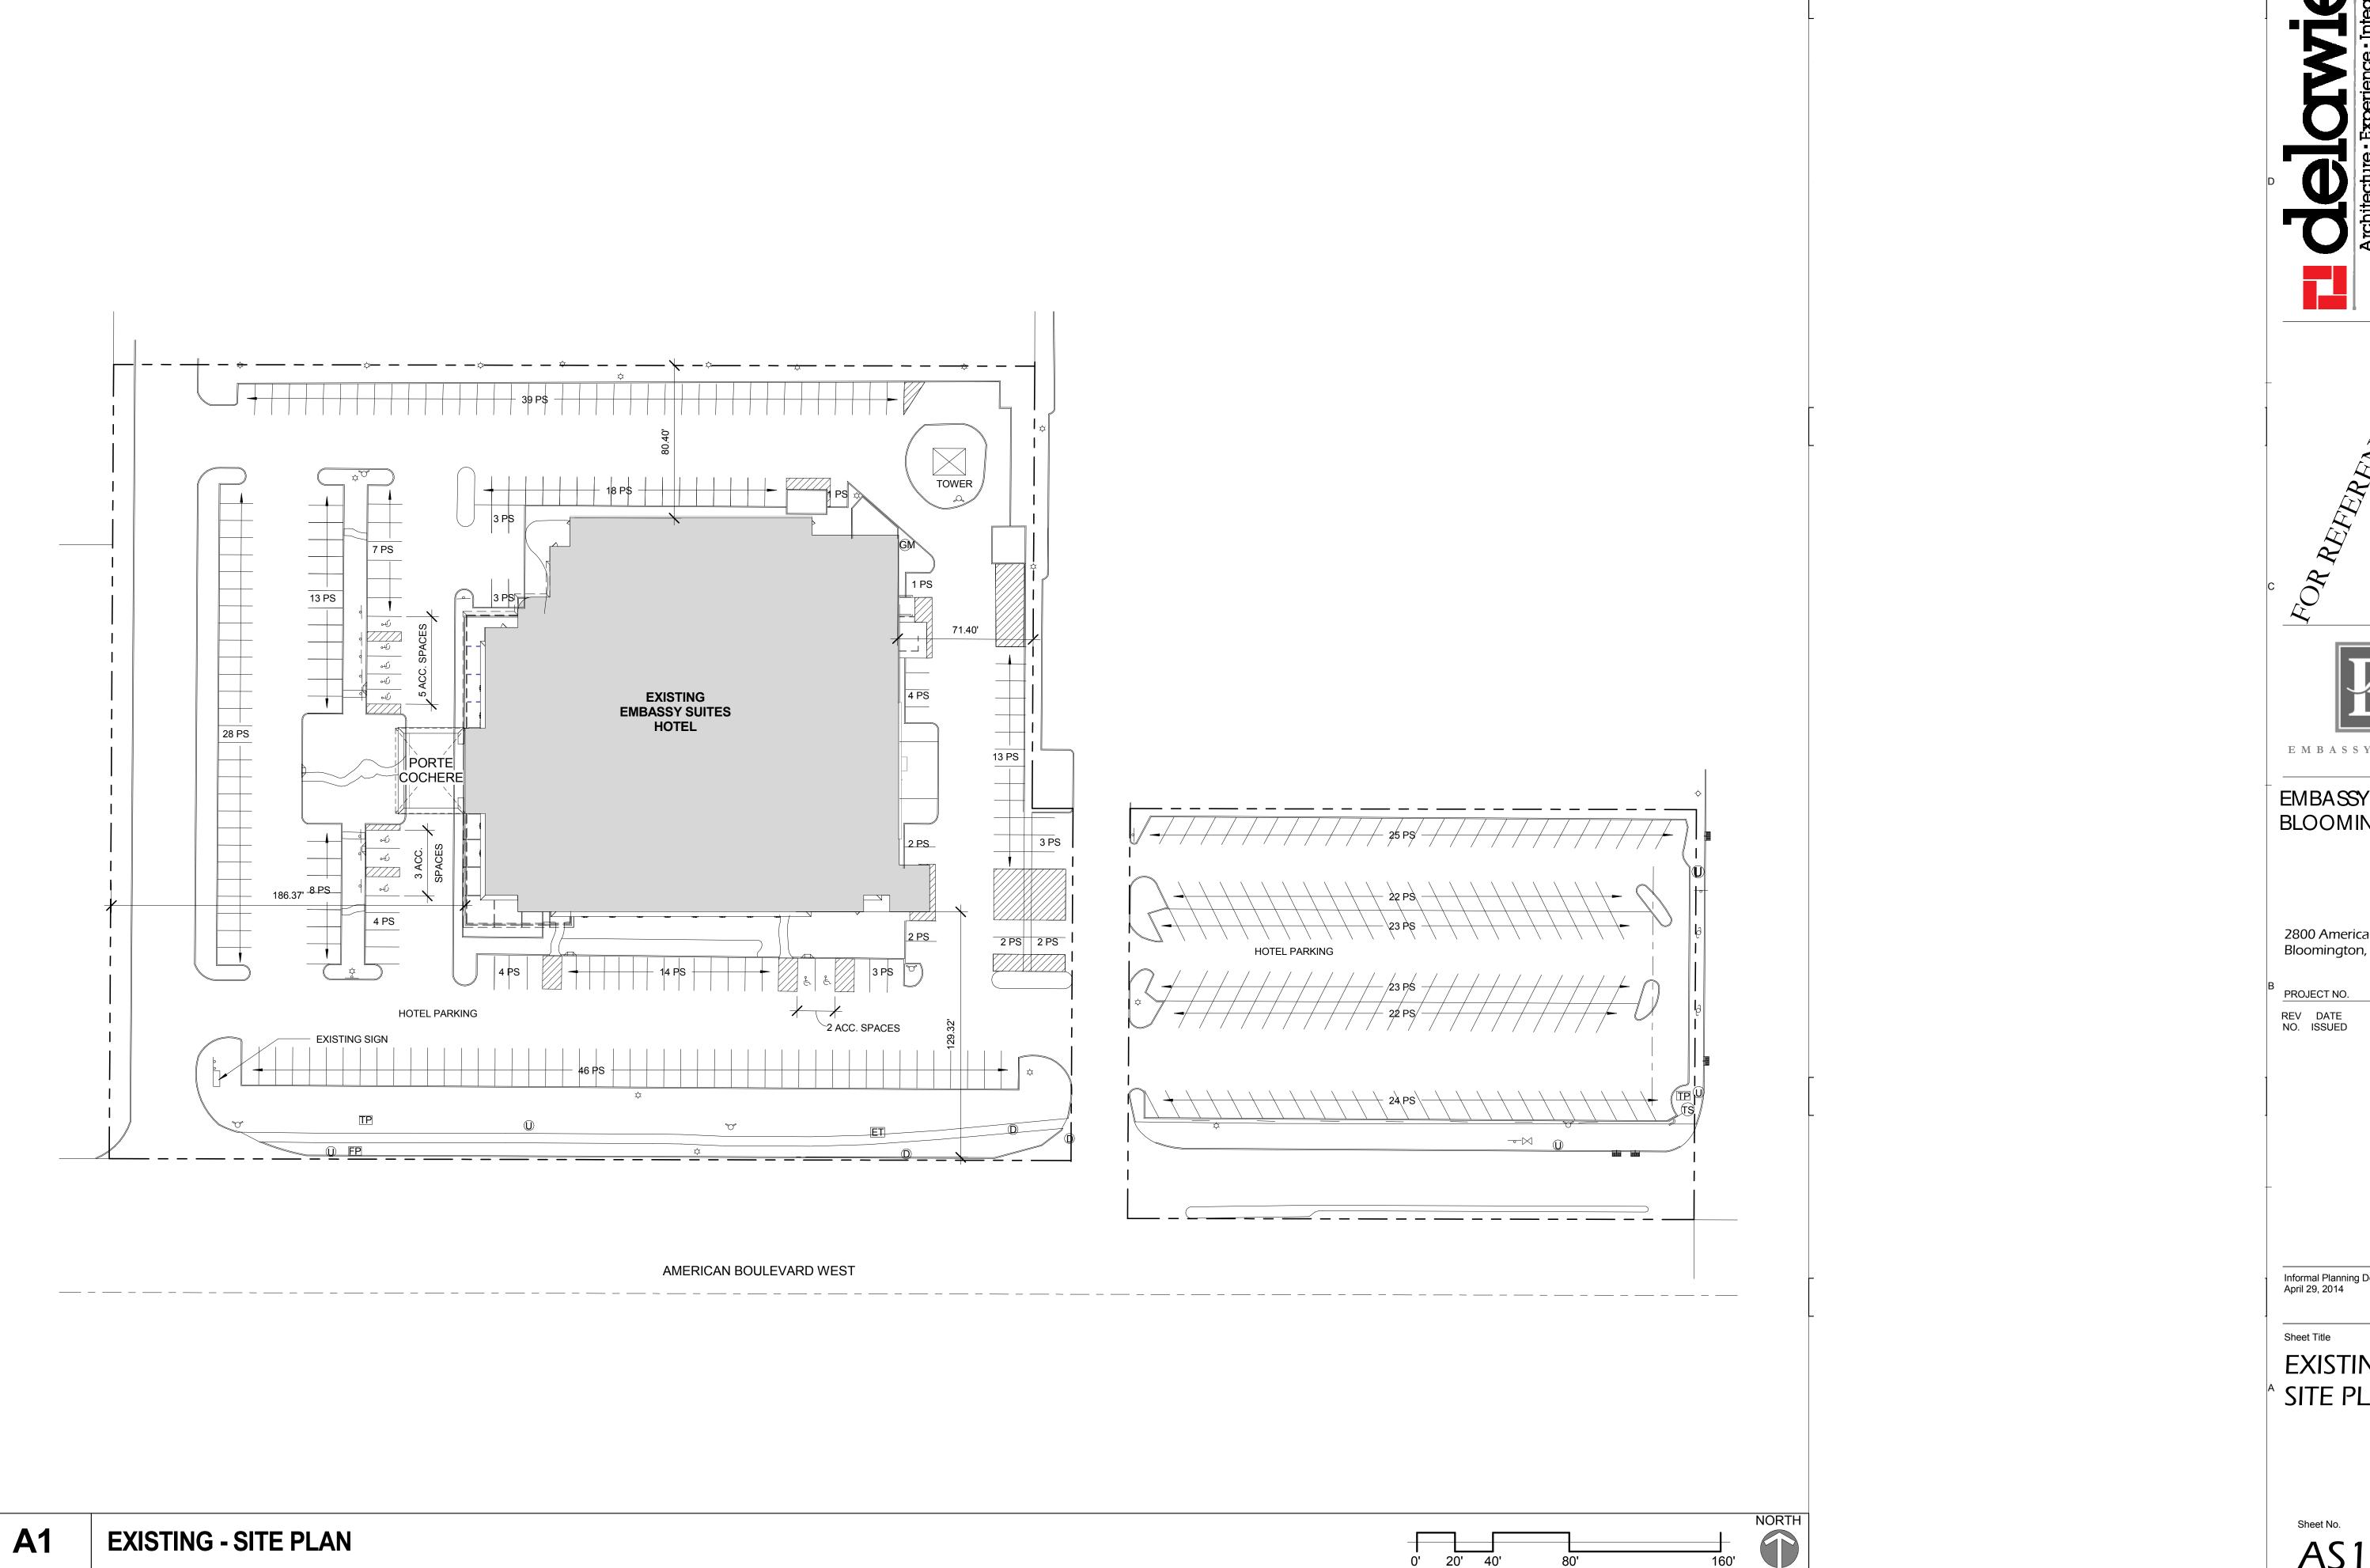

1" = 40'-0"

A1/A-201




EMBASSY SUITES-BLOOMINGTON

2800 American Blvd. West, Bloomington, MN 55431

Informal Planning Department Review April 29, 2014

EXISTING SITE PLAN


AS101

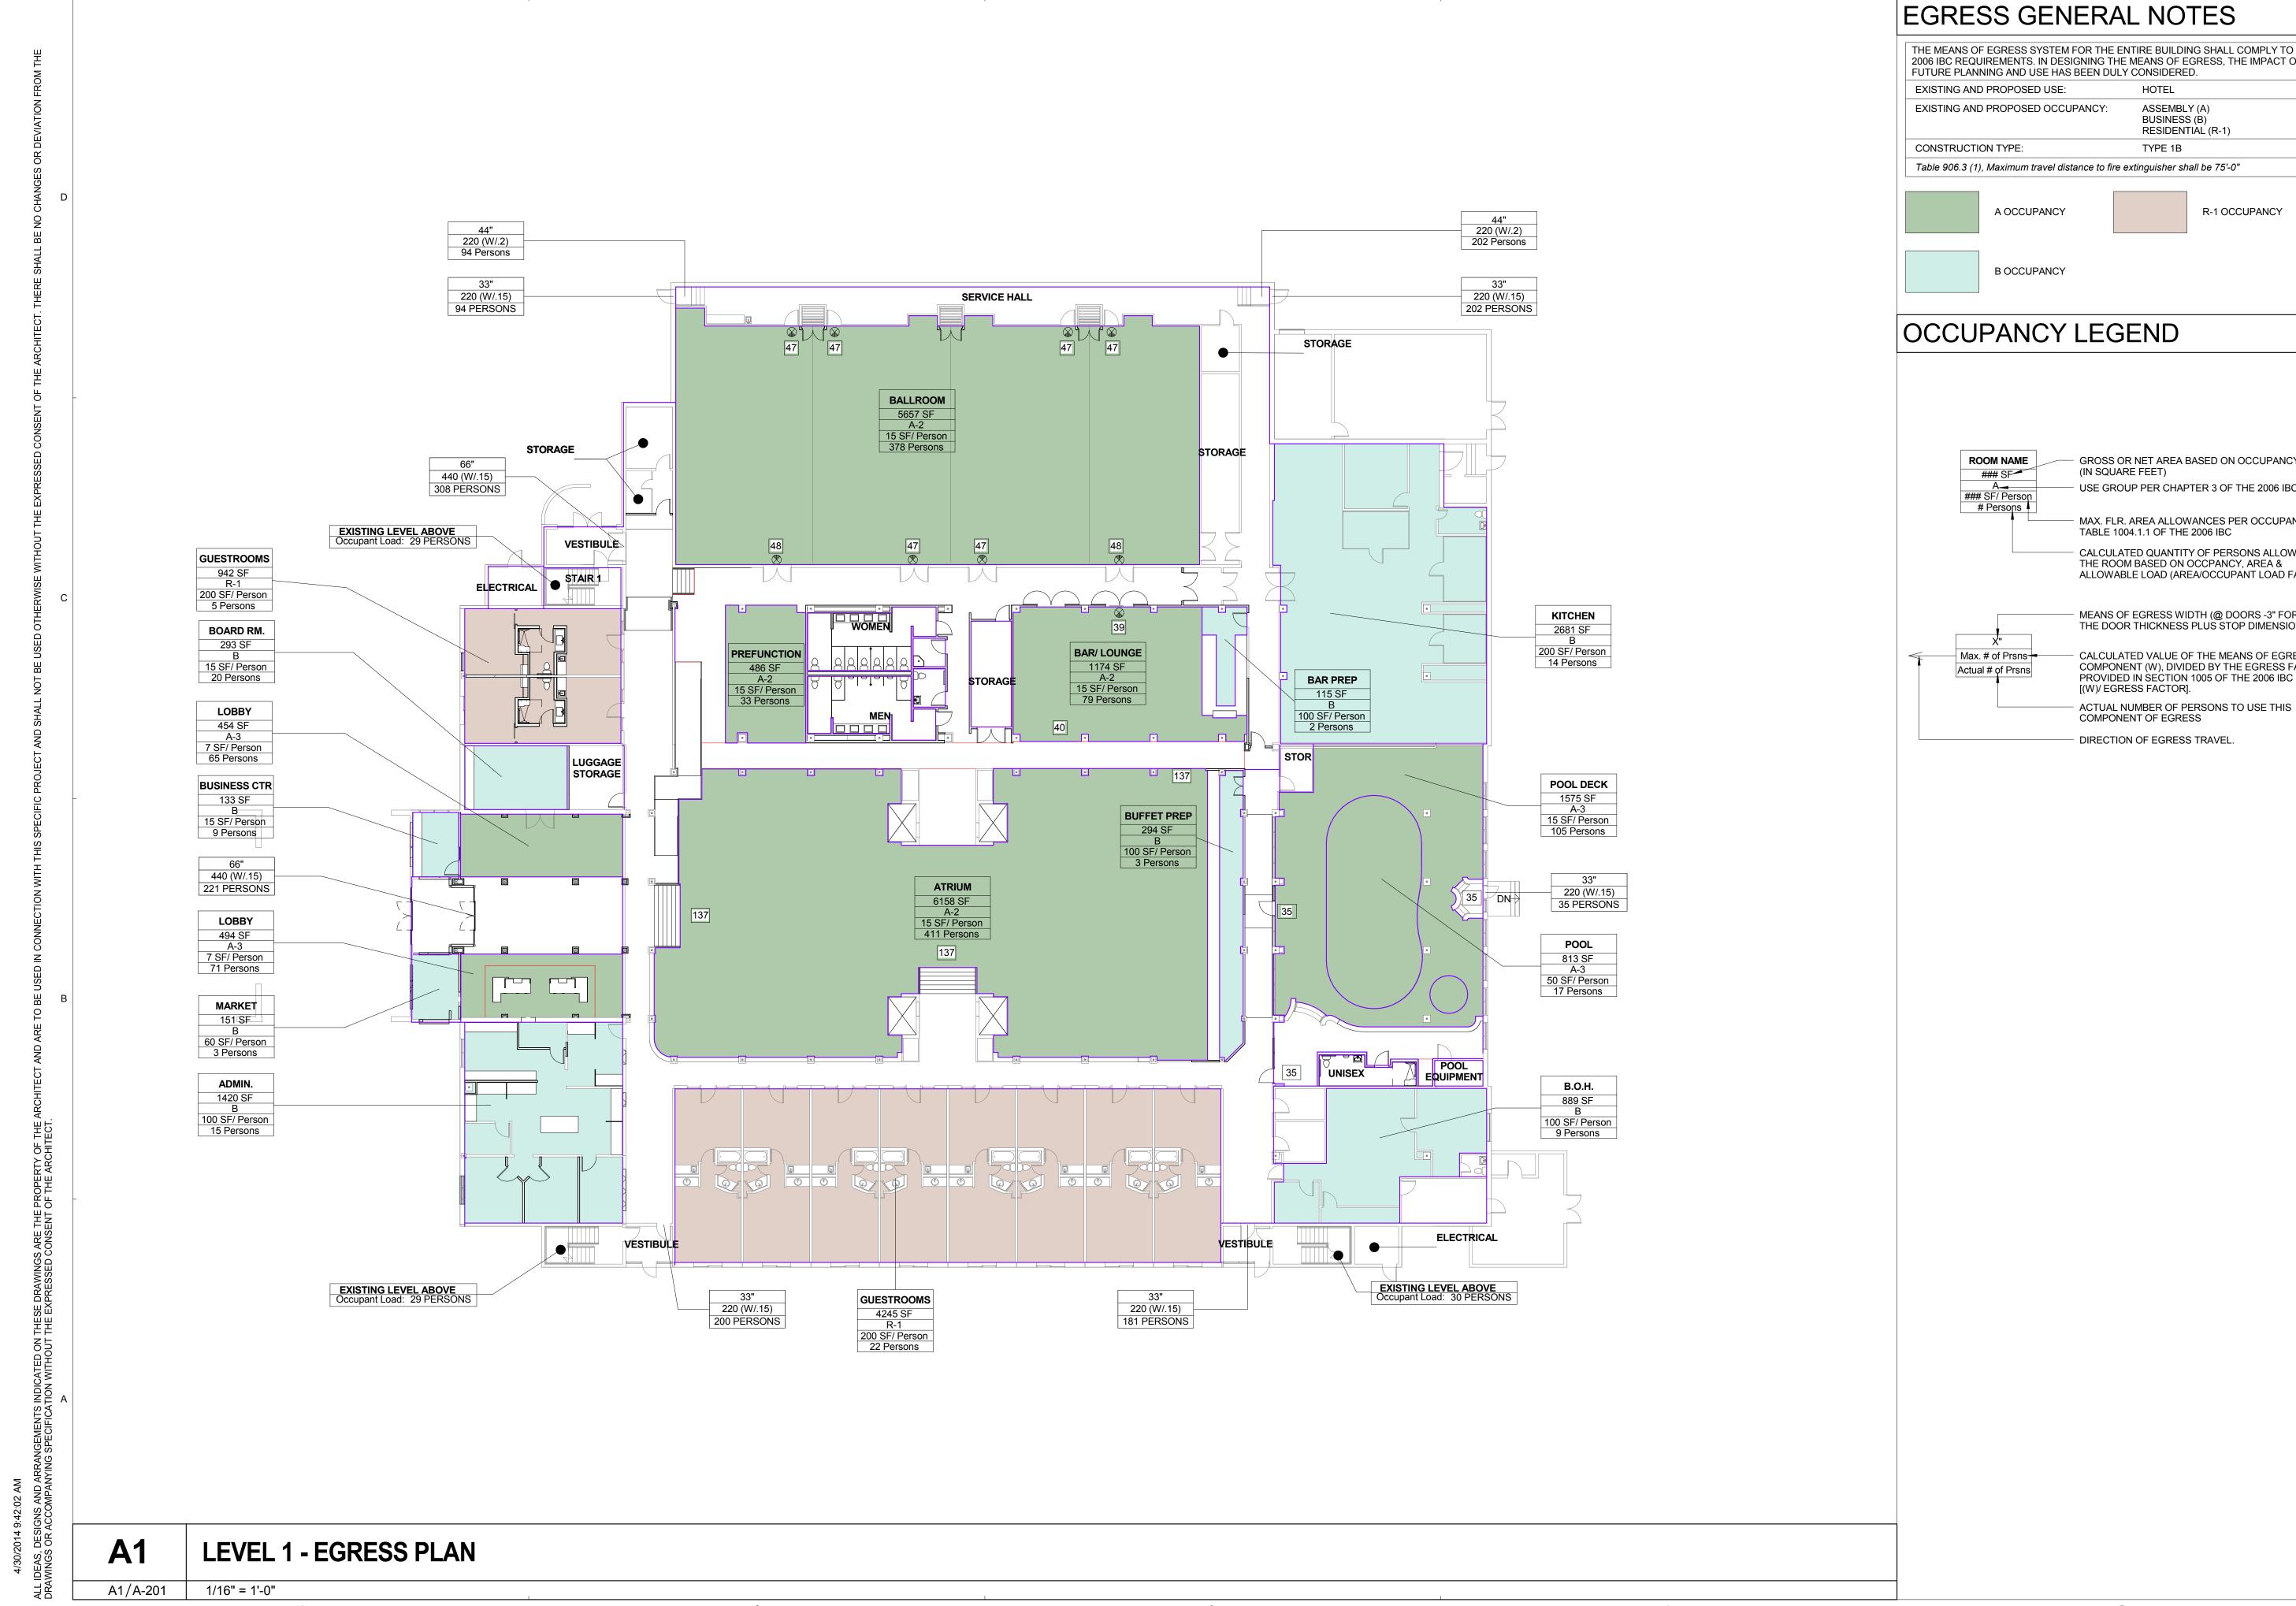

EGRESS GENERAL NOTES

THE MEANS OF EGRESS SYSTEM FOR THE ENTIRE BUILDING SHALL COMPLY TO 2006 IBC REQUIREMENTS. IN DESIGNING THE MEANS OF EGRESS, THE IMPACT OF FUTURE PLANNING AND USE HAS BEEN DULY CONSIDERED. ASSEMBLY (A) BUSINESS (B) RESIDENTIAL (R-1)

R-1 OCCUPANCY

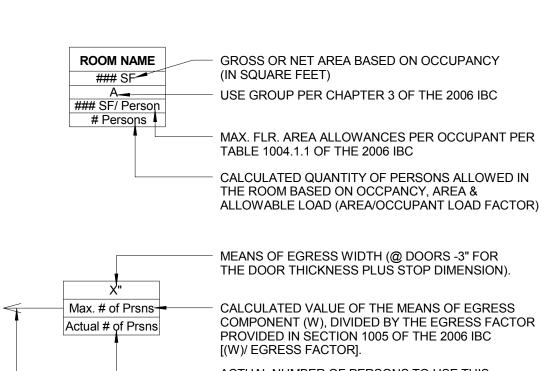

ROR



EMBASSY SUITES-**BLOOMINGTON**

2800 American Blvd. West, Bloomington, MN 55431

PROJECT NO. REV DATE NO. ISSUED REASON

Informal Planning Department Review April 29, 2014

Sheet Title

FIRST LEVEL MEANS OF **EGRESS** PLAN

G-111

